



WEST ELEVATION



NORTH ELEVATION

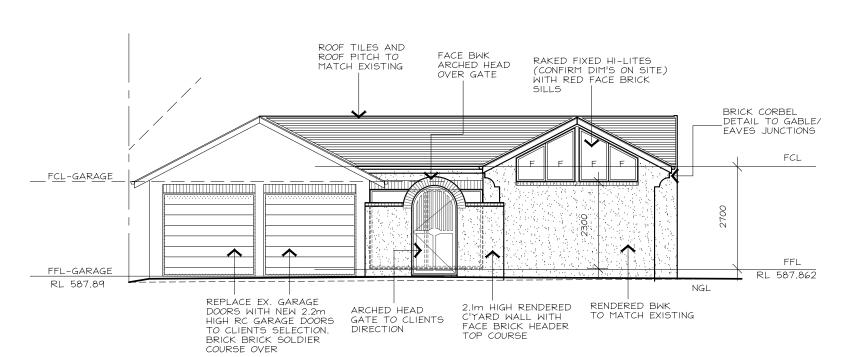

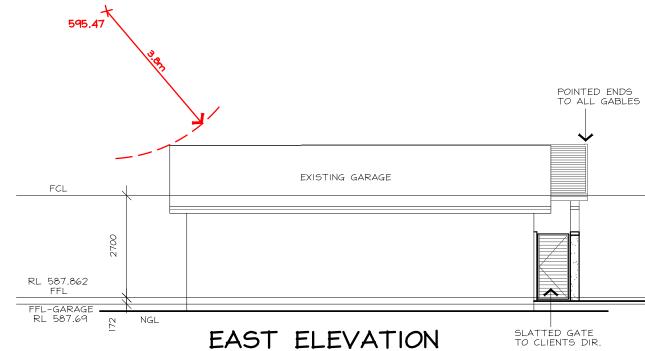

· CONFIRM ALL DIMS ON SITE

BEFORE ORDERING

CLIENT: D SHARMA and A BURTON




PROPOSED DEMOLITION OF

PO BOX 6121 OCONNOR ACT 2602
19A FARRER STREET BRADDON
GINA@GARMODYBYDESIGN.COM.AU
PH: 02 6230 1284

DWN: A.KWONG G.CARMODY

SCALE: 1:100 DATE: 8/8/23

DWG No.: **2303** SHEET: 4 OF 7

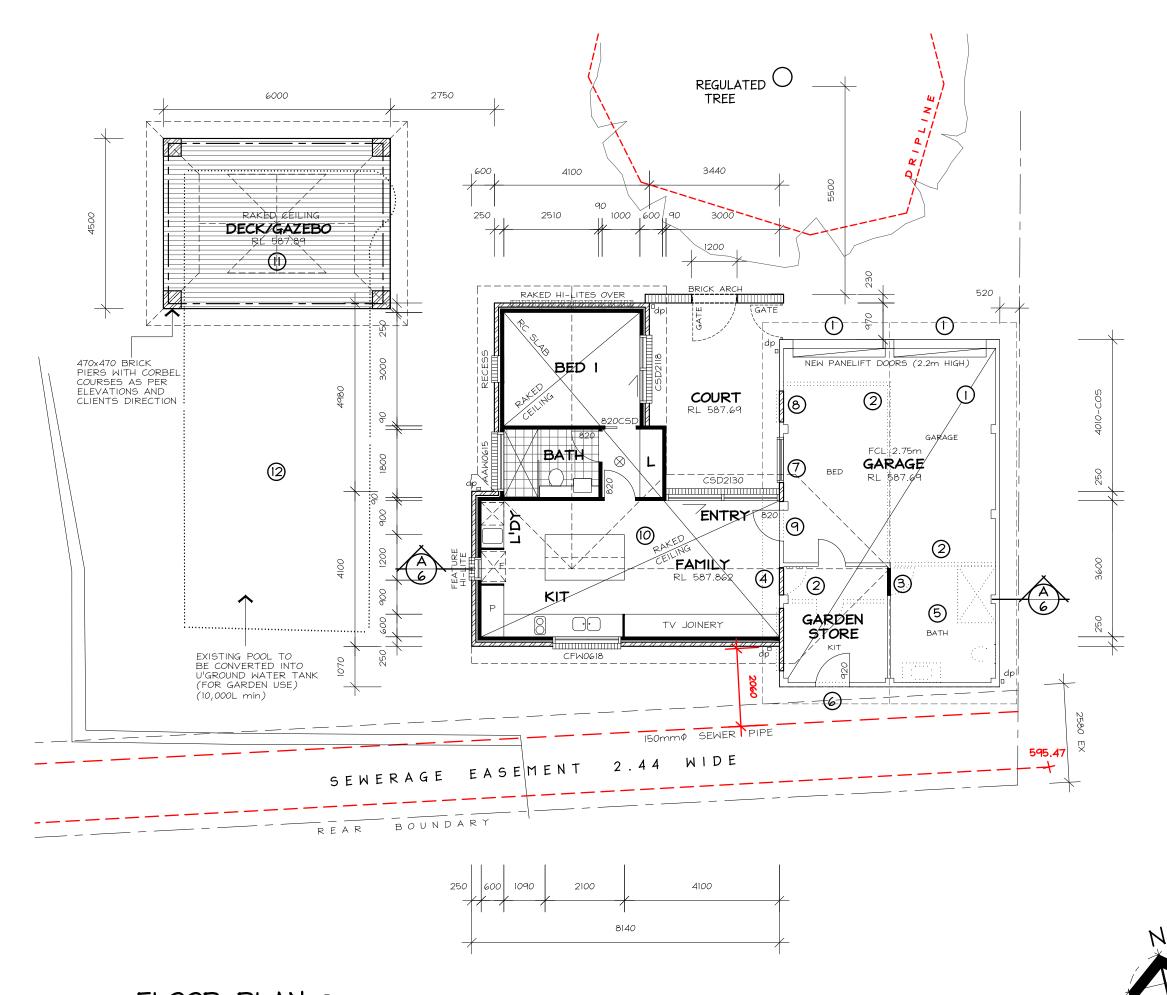

FLOOR PLAN & = SMOKE ALARM

ALTERATIONS

- REMOVE EX. GARAGE DOORS AND INSTALL NEW 2.2m HIGH (COS) PANELIFT DOORS (REMOTE CONTROLLED) AS NOTED. MAKE GOOD
- 2 DEMOLISH INTERNAL WALLS AND MAKE GOOD
- REMOVE EX. DOOR AND BLOCK UP IN STUDFRAMING TO MATCH EXISTING.
- REMOVE EX. DOOR AND BLOCK UP IN BRICKWORK TO MATCH EXISTING. MAKE GOOD
- 5 DEMOLISH EX. BATHROOM FITOUT
- DEMOLISH PART OF BRICK WALL TO INSTALL NEW DOOR TO GARDEN STORE AS SHOWN AND TO CLIENTS DIRECTION. MAKE GOOD
- REPLACE EX. WINDOW WITH NEW 1200W UNIT (TO EX. REVEAL HEIGHT COS). BLOCK UP REMAINING OPENING TO MATCH EXISTING
- 8 REMOVE EX. WINDOW AND BLOCK UP TO MATCH EXISTING
- DEMOLISH EX. WALL AS REQ'D TO INSTALL NEW SOLID DOOR TO CLIENTS DIRECT. MAKE GOOD
- 10 BUILD NEW I BEDROOM DWELLING AS SHOWN AND AS PER SECTION A-A.
- II BUILD NEW DECK/GAZEBO AS SHOWN
- 12 EXISTING POOL TO BE CONVERTED INTO UNDERGROUND WATER TANK (FOR GARDEN USE) TO CLIENTS DIRECTION.

PROPOSED DEMOLITION OF EXISTING RESIDENCE AND BUILD NEW RESIDENCE:

BLOCK:

SECTION: 7 FORREST

CLIENT: D SHARMA and


A BURTON of

11 Talbot Street Forrest



PO BOX 6121 O'CONNOR ACT 2602 19A FARRER STREET BRADDON GINA@CARMODYBYDESIGN.COM.AU PH: 02 6230 1284

DWN: A.KWONG G.CARMODY SCALE: 1:100 DATE: 8/8/23 DWG No.: 2303 SHEET: 3 OF 7

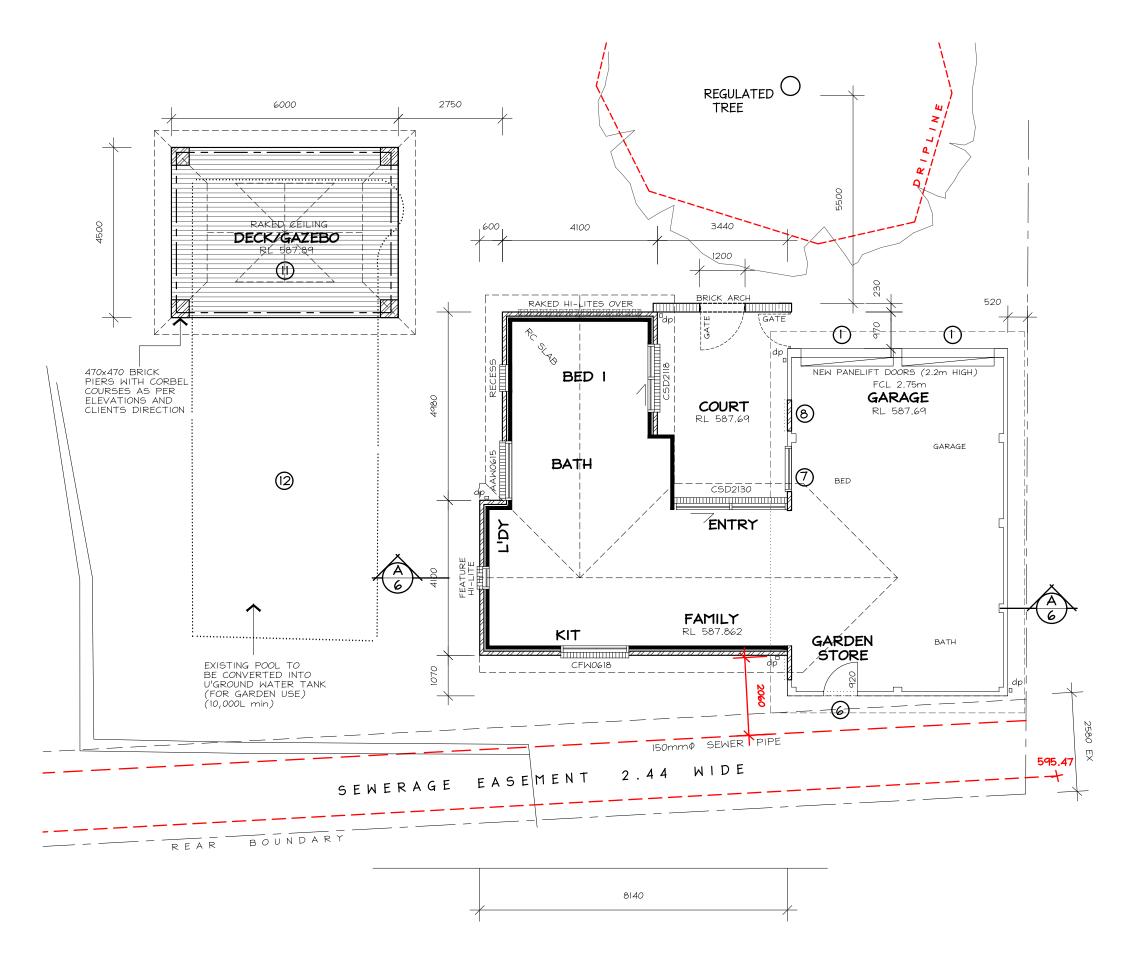

NOTIFICATION FLOOR PLAN & = SMOKE ALARM

ALTERATIONS

- REMOVE EX. GARAGE DOORS AND INSTALL NEW 2.2m HIGH (COS) PANELIFT DOORS (REMOTE CONTROLLED) AS NOTED. MAKE GOOD
- 2 DEMOLISH INTERNAL WALLS AND MAKE GOOD
- 3 REMOVE EX. DOOR AND BLOCK UP IN STUDFRAMING TO MATCH EXISTING.
- 4 REMOVE EX. DOOR AND BLOCK UP IN BRICKWORK TO MATCH EXISTING. MAKE GOOD
- 5 DEMOLISH EX. BATHROOM FITOUT
- 6 DEMOLISH PART OF BRICK WALL TO INSTALL NEW DOOR TO GARDEN STORE AS SHOWN AND TO CLIENTS DIRECTION. MAKE GOOD
- 7 REPLACE EX. WINDOW WITH NEW 1200W UNIT (TO EX. REVEAL HEIGHT - COS). BLOCK UP REMAINING OPENING TO MATCH EXISTING
- 8 REMOVE EX. WINDOW AND BLOCK UP TO MATCH EXISTING
- 9 DEMOLISH EX. WALL AS REQ'D TO INSTALL NEW SOLID DOOR TO CLIENTS DIRECT. MAKE GOOD
- 10 BUILD NEW I BEDROOM DWELLING AS SHOWN AND AS PER SECTION A-A.
- II BUILD NEW DECK/GAZEBO AS SHOWN
- 12 EXISTING POOL TO BE CONVERTED INTO UNDERGROUND WATER TANK (FOR GARDEN USE) TO CLIENTS DIRECTION.

PROPOSED DEMOLITION OF EXISTING RESIDENCE AND BUILD NEW RESIDENCE:

BLOCK: 4

SECTION: 7 FORREST

CLIENT: D SHARMA and A BURTON of

11 Talbot Street Forrest




PO BOX 6121 O'CONNOR ACT 2602
19A FARRER STREET BRADDON
GINA@GARMODYBYDESIGN.COM.AU
PH: 02 6230 1284

DWN: A.KWONG G.CARMODY SCALE: 1:100 DATE: 8/8/23

DWG No.: 2303 SHEET: 3 OF 7




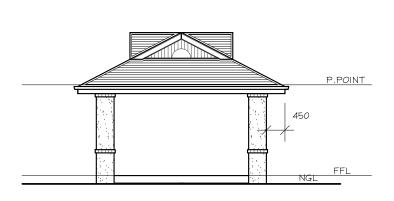


FEATURE DUTCH ROOF TILES AND GABLES TO CLIENTS ROOF PITCH TO MATCH EX. (27.5°) 470×470 RENDERED BWK PIERS WITH RAKED CEILING FACE BWK CORBEL WITH EXPOSED RAFTERS/FRAMING P POINT NGL HW DECKING TO CLIENTS SELECTION ON PC METAL DECK FRAMING TO NCC

EAST ELEVATION


NORTH ELEVATION

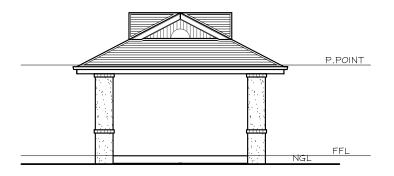

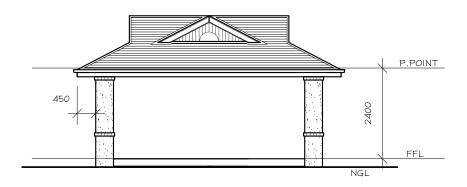

WEST ELEVATION

SOUTH ELEVATION

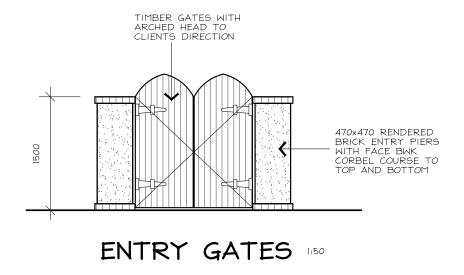

GENERAL NOTES: (WHERE APPLICABLE)

ALL LEVELS, SITE CUTS, GROUND LEVELS, FFL'S TO BE CONFIRMED ON SITE PRIOR TO THE COMMENCEMENT OF ANY WORKS (INCLUDING DRIVEWAY LEVELS)

ANY DISCREPANCIES TO BE DIRECTED TO BUILDER AND/OR DESIGNER IMMEDIATELY

INCLUSIONS LIST TO TAKE PRECEDENCE OVER DRAWINGS

CARRY OUT ALL WORK IN COMPLIANCE WITH THE RELEVANT SAA CODES OF PRACTICE IN THE BEST TRADESMAN-LIKE MANNER TO THE APPROVAL OF THE BUILDING CERTIFIER AND AUTHORITIES HAVING JURISDICTION OVER THE WORKS INCLUDING BUT NOT RESTRICTED TO:
A) ACT GOVERNMENT

B) NATIONAL CONSTRUCTION CODE OF AUSTRALIA C) ACT ELECTRICITY AND WATER

ASI684 TIMBER FRAMING CODE AND AS FURTHER

ALL DIMENSIONS MUST BE VERIFIED ON SITE BEFORE COMMENCING ANY WORK OR MAKING ANY SHOP DRAWINGS. USE FIGURED DIMENSIONS ONLY AND DO NOT SCALE OFF THE

SURVEYOR TO CONFIRM EASEMENT LOCATIONS PRIOR TO COMMENCEMENT OF ANY WORKS

THE BCA, ALL OTHER RELEVANT CODES AND AUSTRALIAN STANDARDS MATERIALS AND WORKMANSHIP TO BE IN ACCORDANCE WITH

PROVIDE SMOKE ALARMS IN ACCORDANCE WITH PART 3.7.2.2 IN ACCORDANCE WITH AS3786 AND NCC-VOL 2

ALL WINDOWS/GLAZED DOORS TO BE DOUBLE GLAZED ALUMINIUM IMPROVED FRAMES (UNLESS NOTED OTHERWISE) AS PER ATTACHED EER.

LIGHTING TO COMPLY WITH 3.12.5.5 OF THE N.C.C

ALL TIMBER FRAMING AND CONSTRUCTION TO BE IN ACCORDANCE WITH THE LATEST TIMBER FRAMING CODE ASI684 AND N.C.C

EXTERNAL WALLS TO BE BRICK VENEER UNLESS STATED ON PLANS, WHEN LIGHTWEIGHT CLADDING IS USED IT IS TO BE INSTALLED TO MANUFACTURERS SPECIFICATIONS AND SARKED AND INSULATED AS PER THE N.C.C AND ATTACHED EER.

ALL INSULATION R VALUES AND WINDOW SHGC AND U-VALUES

ALL OPENABLE WINDOWS AND SLIDING DOORS TO HAVE FLYSCREENS TO BE POWDERCOATED ALUMINIUM FRAMES TO MATCH WINDOWS, NOTE: METALLIC FLYSCREENS ARE REQUIRED IN BUSHFIRE PRONE AREAS

REFER TO STRUCTURAL ENGINEER'S ATTACHED DOCUMENTATION FOR ALL STRUCTURAL DETAILS

ALL EXTERNAL WINDOWS TO HAVE BRICK ON EDGE WINDOW SILLS WITH DAMP PROOF MEMBRANE UNDER TO N.C.C

PROVIDE TERMITE PROTECTION TO CODE AND AS3660-2014 PARTS I, 2 AND 3

ALL NEW STAIRS TO COMPLY WITH N.C.C

3.1.4 TERMITE RISK DAMAGE - NEW WORK WILL BE COMPLIANT WITH THE N.C.C.

3.5.4 TIMBER ¢ COMPOSITE WALL CLADDING - WEATHERTEX CLADDING TO MAN. SPECIFICATIONS.

3.8.7 CONDENSATION MANAGEMENT - NEW WORK WILL BE COMPLIANT WITH THE N.C.C AND MAN . SPECIFICATIONS

SERVICES/ELECTRICAL/WASTE:

NO INTERNAL DRAINAGE FOR PROPOSED STRUCTURE TO BE LOCATED IN SEWER EASEMENT/PIPE PROTECTION ENVELOPE. ALL WORKS DONE TO ACTEW GUIDELINES/ADVICE

ALL BUILDING WASTE TO BE COLLECTED IN HOPPER LOCATED ON SITE, RESIDENTIAL WASTE TO BE COLLECTED BY ROADSIDE PICKUP AND BINS TO BE LOCATED ON SITE

METER BOX TO BE INSTALLED TO EVOENERGY SERVICE AND INSTALLATION RULES

LIGHTING TO COMPLY WITH 3.12.5.5 OF THE N.C.C - REFER ELECTRICAL LAYOUT. ARTIFICIAL LIGHTING MUST NOT EXCEED

WATER HEATER IN HOT WATER SUPPLY SYSTEM TO COMPLY WITH N.C.C AND TO MAN. SPECIFICATIONS

STORMWATER AND SEWER AND WATER TIES TO BE LOCATED ON HYDRAULIC/DRAINAGE PLANS

TELSTRA AND GAS TIES TO BE PROVIDED BY GAS FITTER AND ELECTRICIAN

DOWNPIPES TO ROOF PLUMBERS SPECIFICATIONS

ENSURE THAT THE DEVELOPMENT COMPLIES WITH TERRITORY AND MUNICIPAL SERVICES (TAMS) STATING THAT WASTE FACILITIES AND MANAGEMENT ASSOCIATED WITH DEVELOPMENT ARE IN ACCORDANCE WITH THE DEVELOPMENT CONTROL CODE FOR BEST PRACTICE WASTE MANAGEMENT IN

PROPOSED DEMOLITION OF EXISTING RESIDENCE AND BUILD NEW RESIDENCE:

BLOCK: SECTION: 7 **FORREST** CLIENT: D SHARMA and A BURTON of

11 Talbot Street Forrest



PO BOX 6121 O'CONNOR ACT 2602 19A FARRER STREET BRADDON PH: 02 6230 1284

DWN: A.KWONG G.CARMODY

SCALE: 1:100 DATE: 8/8/23

DWG No.: 2303 SHEET: 5 OF 7

Report from 11 Tallbot Street, Glazing Calculator - Ground Floor 23.5.23



1. Enter building name and description below - identifying the particular part(s) covered by this assessment. C_U C_{SHGC} Climate Zone Constants 5.486 0.189 11 Talbot Street, Forrest ACT - ground floor 7 Floor Construction Storey Ground Direct Contact 109m² Wall Insulation Option Chosen for 3.12.1.4 C_{SHGC} x Area Air Movement Suspended No wall insulation concession used **Allowances** Area of storey 109m² 5.5 Standard 20.6 Area of glazing 18.2m² (17% of area of storey)

Number of rows for table below 10 (as currently displayed)

Glazing Elements, Orientation Sector, Size and Performance Characteristics									Shading		Calculation Data			Calculated Outcomes			
	Glazing element	Orientation	on Size			Performance			P&H or Device		Exposure		Conductance - PASSED		Solar heat gain - PASSED		
ID	Description (optional)	Facing Sector	Height (m)	Width (m)	Area (m²)	Total System U-Value (AFRC)	Total System SHGC (AFRC)	P (m)	H (m)	P/H	Es	Area used (m²)	Winter	Element Share of % of Allowance Used	SHGC x Es x Area	Element Share of % of Allowance Used	
	1 W01 - entry	N	2.10	3.00		2.60	0.50	0.45	2.65	0.08	0.78	6.30	1.25	33% of 69%	2.5	30% of 39%	
	2 W02 - bed 1	E	2.10	1.80		2.60	0.50	0.45	2.65	0.08	1.06	3.78	0.75	20% of 69%	2.0	25% of 39%	
	3 W03 - bed 1	N	1.05	4.00		2.60	0.50				0.96	4.20	0.83	22% of 69%	2.0	25% of 39%	
	4 W04 - bathroom	W	0.60	1.50		4.90	0.49	0.45	0.85	0.53	0.67	0.90	0.34	9% of 69%	0.3	4% of 39%	
	5 W05 - kitchen hi-lite	W	1.20	0.71		3.40	0.49				1.19	0.85	0.22	6% of 69%	0.5	6% of 39%	
	6 W06 - kitchen	S	0.60	1.80		2.60	0.50	0.45	1.75	0.13	0.49	1.08	0.21	6% of 69%	0.3	3% of 39%	
	7 W07 - garage	W	0.90	1.20		2.60	0.50	0.15	1.45	0.05	1.09	1.08	0.21	6% of 69%	0.6	7% of 39%	
	8																
	9																
	10																





IMPORTANT NOTICE AND DISCLAIMER IN RESPECT OF THE GLAZING CALCULATOR


If inputs (including air movement levels) are valid

By accessing or using this calculator, you agree to the following: While care has been taken in the preparation of this calculator, it may not be complete or up-to-date. You can ensure that you are using a complete and up-to-date version by checking the Australian Building Codes Board website (www.abcb.nov.au/. The Australian Building Codes Board website (https://www.abcb.nov.au/. The Australian Building Codes Board website (https://www.abcb.nov.au/. The Australian Building Codes Board website (<

OFFICIAL page 1 of 1

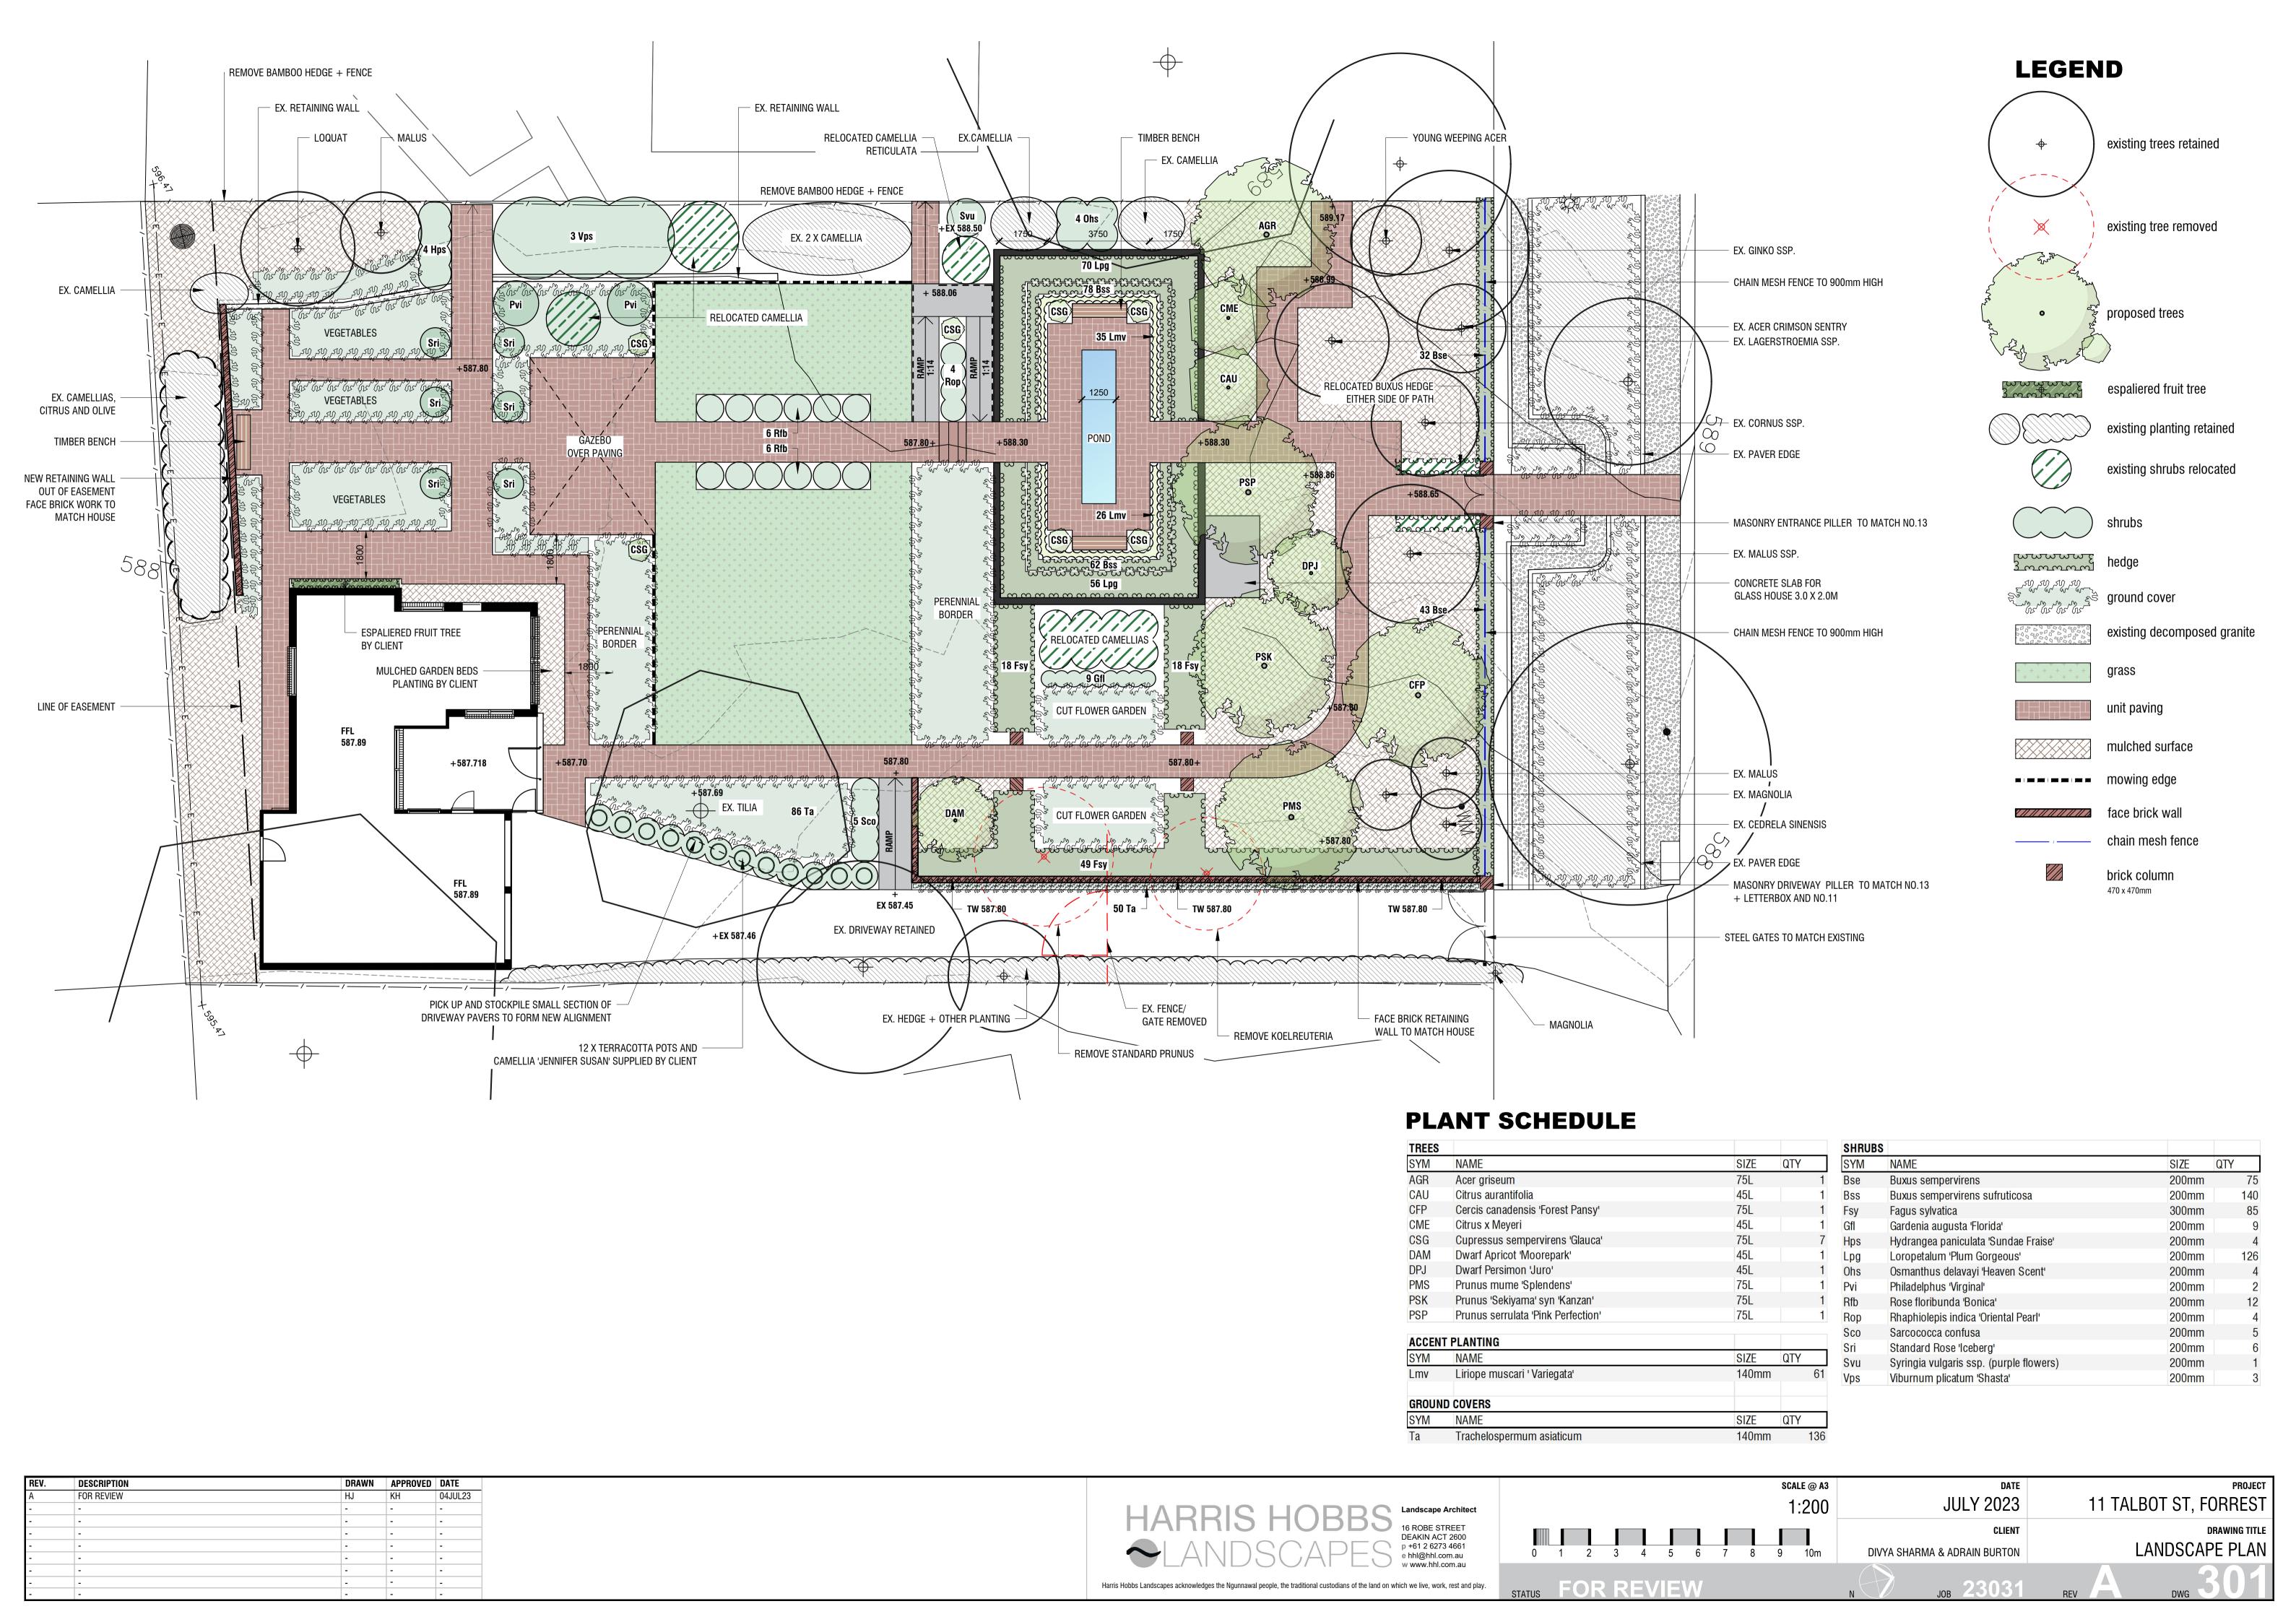

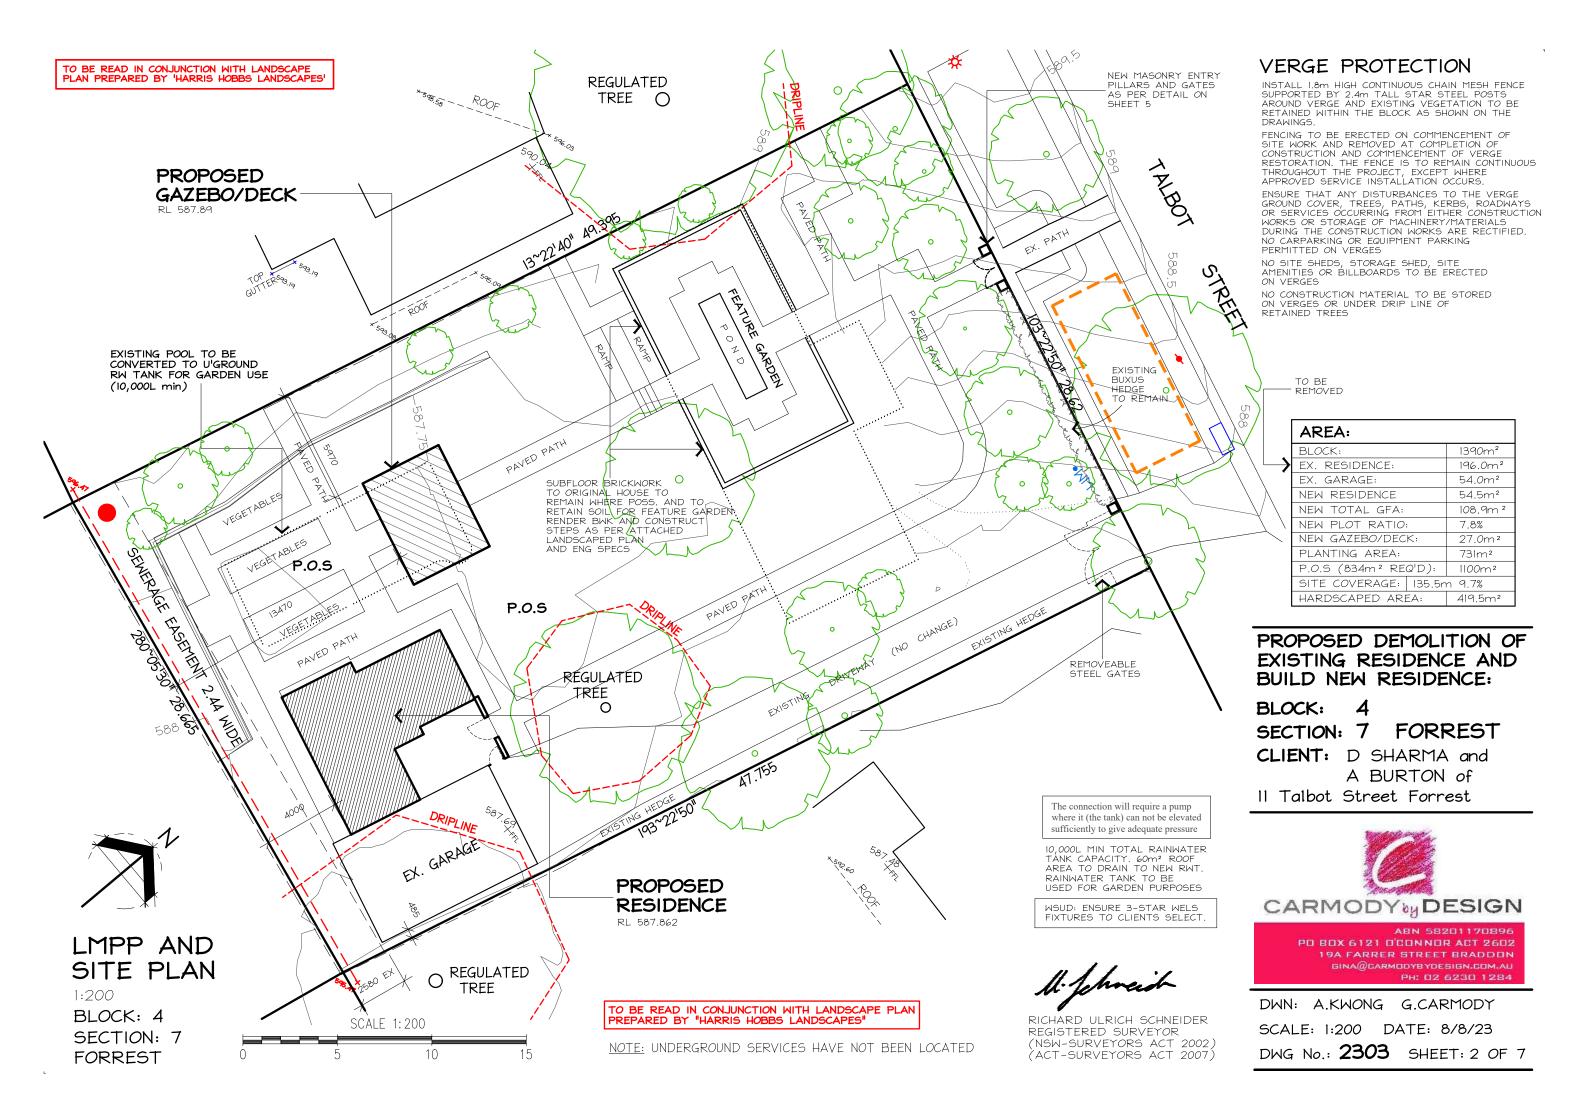

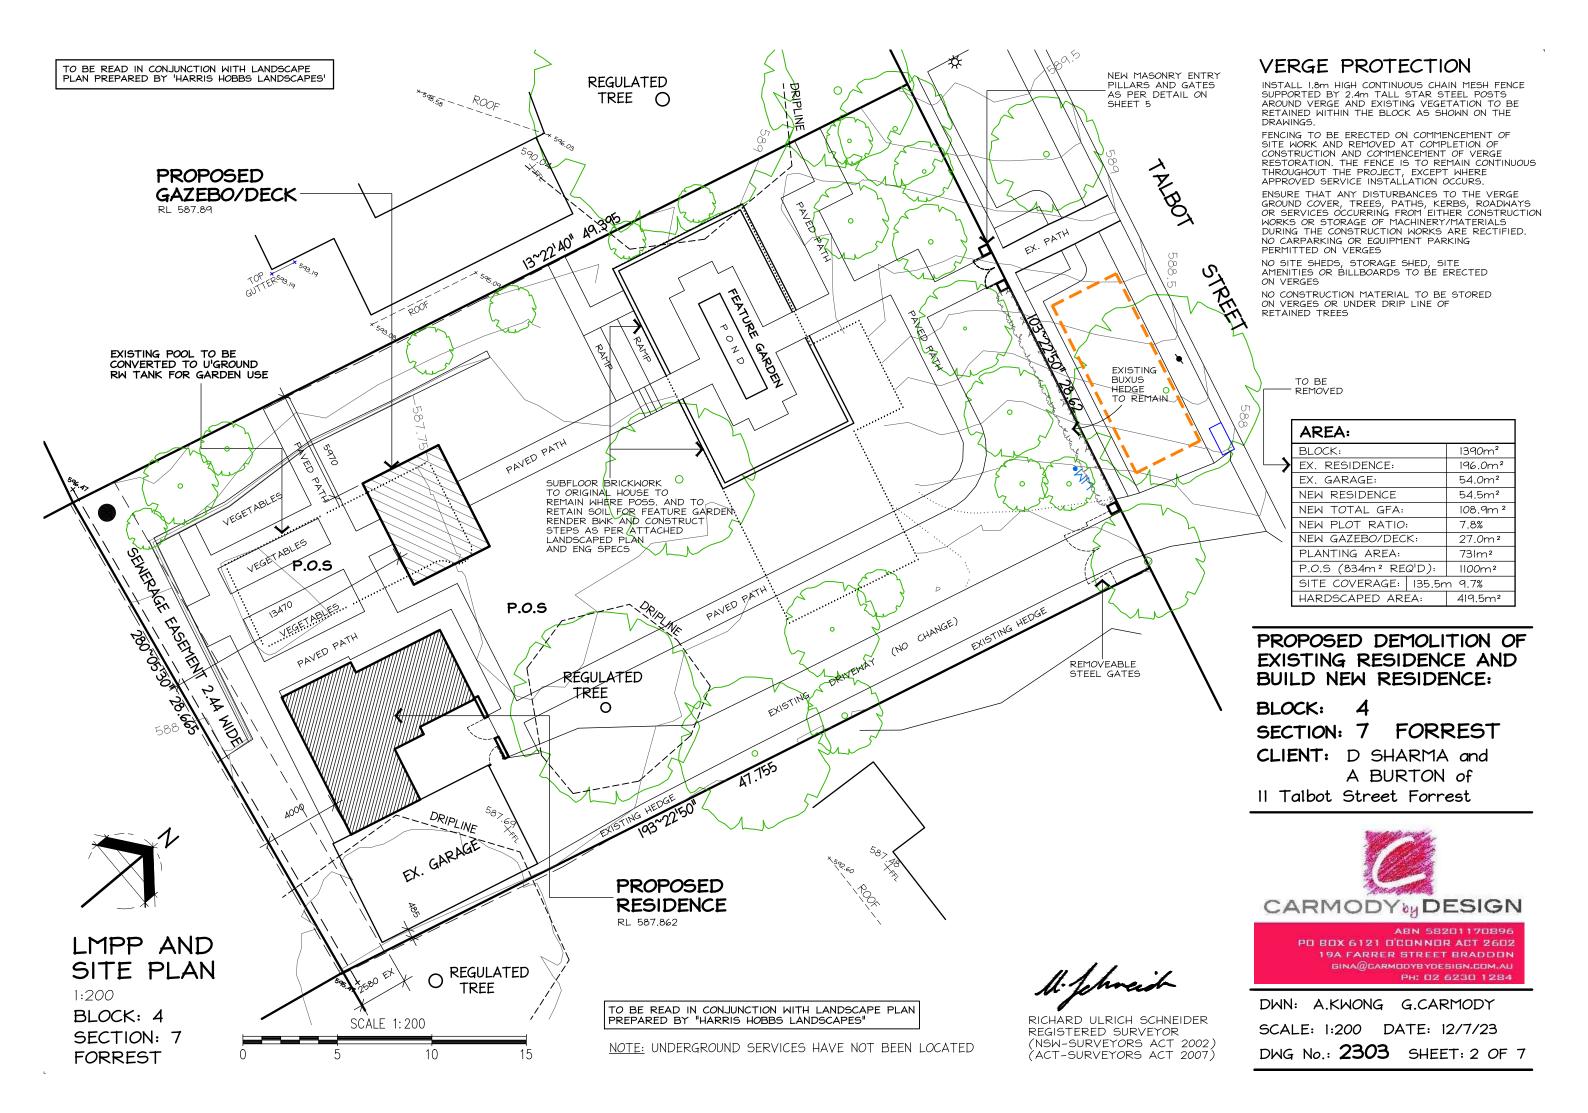

WATERPROOFING NOTES:

SHOWER AREAS: ENCLOSED AND UNENCLOSED (INCLUDING SHOWER OVER BATH) MUST CONSIDER THE FOLLOWING:

FLOOR OF THE SHOWER AREA MUST BE WATERPROOF - INCLUDING ANY HOB OR STEP DOWN.

MALLS TO BE WATER RESISTANT TO NOT LESS THAN 1800mm
ABOVE FINISHED FLOOR LEVEL AND WATERPROOF NOT LESS THAN
150mm ABOVE FLOOR SUBSTRATE; OR NOT LESS THAN 25mm

ABOVE FLOOR SUBSTRATE; OR NOT LESS THAN 25MM
ABOVE MAXIMUM RETAINED WATER LEVEL; AND
WALL JUNCTIONS AND JOINTS TO BE WATERPROOF NOT LESS THAN
40mm EITHER SIDE OF THE JUNCTION.
WALL/FLOOR JUNCTIONS TO BE WATERPROOF.
PENETRATIONS TO BE WATERPROOF - PROTECTION CAPS MUST BE

REMOVED PRIOR TO WATERPROOFING

OUTSIDE SHOWER AREAS:

FLOOR CONCRETE AND COMPRESSED FIBRE-CEMENT SHEET FLOORING MUST BE WATER RESISTANT.

TIMBER FLOORS INCLUDING PARTICLEBOARD, PLYWOOD AND OTHER

TIMBER-BASED FLOORING MATERIALS MUST BE WATERPROOF WALL/FLOOR JUNCTIONS MUST BE WATERPROOF.

BATHROOM ENTRY TO BE WATERPROOF MIN 25mm ABOVE FINISHED

THE DOORWAY WATERSTOP REQUIRES THE BASE TO BE SEALED TO FLOOR AND UPSTAND FLUSH WITH FINISHED FLOOR SURFACE

AREAS ADJACENT TO BATHS AND SPAS (VESSEL): FLOOR CONCRETE, COMPRESSED FIBRE-CEMENT AND FIBRE-CEMENT SHEET - MUST BE WATER RESISTANT.

SHEET - MUST BE WATER RESISTANT.

TIMBER FLOOR INCLUDING PARTICLEBOARD, PLYWOOD AND OTHER

TIMBER-BASED FLOORING MATERIALS - MUST BE WATERPROOF.

WALLS WATER RESISTANT TO A HEIGHT OF NOT LESS THAN ISOMM

ABOVE THE VESSEL, FOR THE EXTENT OF THE VESSEL, WHERE THE

VESSEL IS WITHIN 75mm OF A WALL. ALL EXPOSED SURFACES

BELOW VESSEL LIP - MUST BE WATER RESISTANT. WALL JUNCTIONS AND JOINTS TO BE WATER RESISTANT WHEN LOCATED WITHIN 150mm ABOVE A VESSEL FOR THE EXTENT OF THE

WALL/FLOOR JUNCTIONS TO BE WATER RESISTANT FOR THE EXTENT OF THE VESSEL

OF THE VESSEL.
PENETRATIONS TAP AND SPOUT PENETRATIONS TO BE WATERPROOF WHERE THEY OCCUR IN HORIZONTAL SURFACES, PROTECTION CAPS MUST BE REMOVED PRIOR TO WATERPROOFING

INSERTED BATHS AND SPAS: FLOOR WATERPROOF SHELF AREA, INCORPORATING WATERSTOP UNDER THE BATH LIP.

WALL TO BE WATERPROOF TO NOT LESS THAN 150mm ABOVE THE LIP OF THE BATH OR SPA; AND NO REQUIREMENT UNDER BATH.

MALL JUNCTIONS AND JOINTS WITHIN 150mm ABOVE BATH OR SPA; AND NO REQUIREMENT UNDER BATH. PENETRATIONS TAP AND SPOUT PENETRATIONS TO BE WATERPROOF

WHERE THEY OCCUR IN HORIZONTAL SURFACES. PROTECTION CAPS MUST BE REMOVED PRIOR TO WATERPROOFING.

LAUNDRIES AND MC's: FLOOR REQUIRED TO BE WATER RESISTANT. WALL/FLOOR JUNCTIONS REQUIRED TO BE WATER RESISTANT.

WALLS ADJOINING SINK, BASIN OR LAUNDRY TUB (VESSEL) WALLS TO BE WATER RESISTANT TO A HEIGHT OF NOT LESS THAN 150mm ABOVE THE VESSEL, FOR THE EXTENT OF THE VESSEL,

WHERE THE VESSEL IS WITHIN 75mm OF A WALL. WALL JUNCTIONS WATERPROOF WHERE A VESSEL IS FIXED TO A

PENETRATIONS WATERPROOF WHERE THEY OCCUR IN SURFACES REQUIRED TO BE WATERPROOF OR WATER RESISTANT.

MATERIALS - WATERPROOF: THE FOLLOWING MATERIALS USED IN WATERPROOFING SYSTEMS ARE DEEMED TO BE WATERPROOF:

TO MATCH EXISTING

STAINLESS STEEL FLEXIBLE WATERPROOF SHEET FLOORING MATERIAL WITH WATERPROOF JOINTS

MATERIALS - WATER RESISTANT SUBSTRATES: THE FOLLOWING MATERIALS ARE DEEMED TO BE WATER RESISTANT: FOR WALLS

CONCRETE COMPLYING WITH AS3600, TREATED TO RESIST MOISTURE MOVEMENT.

CEMENT RENDER, TREATED TO RESISTN MOISTURE MOVEMENT. COMPRESSED FIBRE-CEMENT SHEETING MANUFACTURED IN

ACCORDANCE WITH AS/NSS 2908.2
WATER RESISTANT PLASTERBOARD SHEETING

MASONRY IN ACCORDANCE WITH AS3700, TREATED TO RESISTANT MOISTURE MOVEMENT.

FOR FLOORS: CONCRETE COMPLYING WITH AS3600. CONCRETE SLABS COMPLYING WITH AS2870. COMPRESSED FIBRE-CEMENT SHEETING MANUFACTURED IN ACCORDANCE WITH AS/NZS 2908.2 AND SUPPORTED ON A STRUCTURAL FLOOR.

MATERIALS - WATER RESISTANT SURFACE MATERIALS THE FOLLOWING SURFACE MATERIALS ARE DEEMED TO BE WATER RESISTANT: FOR WALLS:

THERMOSETTING LAMINATE.
PRE-DECORATED COMPRESSED FIBRE-CEMENT SHEETING
MANUFACTURED IN ACCORDANCE WITH AS2908.2 TILES WHEN USED IN CONJUNCTIONS WITH A COMPLIANT SUBSTRATE SYSTEMS.
WATER RESISTANT FLEXIBLE SHEET WALL MATERIAL

WITH SEALED JOINTS WHEN USED IN CONJUNCTIONS WITH A COMPLIANT SUBSTRATE SYSTEM. SANITARY GRADE ACRYLIC LININGS.

RECOMMENDATIONS:
IT IS RECOMMENDED BUILDING CERTIFIERS ENSURE
ADEQUATE DOCUMENTATION IS SUBMITTED WITH THE BUILDING APPROVAL AS REQUIRED UNDER BUILDING ACT 2004 SECTION 28A AND SECTION 151 - MINIMUM DOCUMENTATION REQUIREMENTS FOR BUILDING LODGEMENT CLASS I \sharp 10 - RESIDENTIAL CONSTRUCTION. BUILDERS SHOULD SUPERVISE AND INSPECT MATERPROOFING TO ENSURE COMPLIANCE PRIOR TO PROCEEDING TO TILING AND FITOUT. ENFORCEMENT ACTION:

ENFORCEMENT ACTION:
WHERE IDENTIFIED, INSUFFICIENT OR INCORRECT
WATERPROOFING OF WET AREAS AND LACK OF
DOCUMENTATION MAY RESULT IN THE ISSUANCE OF A
STOP WORK NOTICE IN ACCORDANCE WITH SECTION 53 OF
THE BUILDING ACT 2004, AND FORMAL LICENCING ACTION INCLUDING ISSUING OF DEMERIT POINTS IN ACCORDANCE WITH SECTION 55 OF THE CONSTRUCTION OCCUPATIONS (LICENSING) ACT 2004.

TERMITE PROOFING TO BCA

SECTION A-A


INSTALLATION:
INSTALLATION OF THE WATERPROOFING TO THE INTERNAL MET AREAS AND EXTERNAL AREAS TO BE CARRIED OUT IN ACCORDANCE WITH AUSTRALIAN STANDARD 3740-2020 AND THE N.C.C - 2022 THE INSTALLATION IS IN ACCORDANCE WITH AS/NZS

ROOF TILES AND ROOF PITCH


WATERPROOFING PRODUCT OR COMPOUND USED

FILLET AND BOND BREAKER USED: NUMBER OF COATS APPLIED:

TO MATCH EX. (27.5°) ON RP CUT ROOF/RAKED CEILING TO ENG. SPEC./ASI684. PROVIDE RI.3 ANTICON AND R5 INSULATION MEMBRANES COMPLYING WITH AS/NZS4858 WATERPROOF SEALANT 90x35 MGP STUDFRAMING TO ASI684. PROVIDE R2.5 HI-DENSITY THERMAL PB LINING TO MATCH EXISTING INSULATION, SISALATION AND PB LINING POINTED ENDS TO ALL GABLES FCL FCL-GARAGE NEW ARCHED HEAD LOUVRED WINDOW -TO CLIENTS DIRECT. WITH FACE BWK GARDEN HEADER COURSE FAMILY GARAGE KIT STORE FFI FFL-GARAGE RL 587.862 RL 587.69 RC SLAB AND FOOTINGS AS PER SLAB AND FOOTING PLAN. PROVIDE WPM AND RENDERED BWK

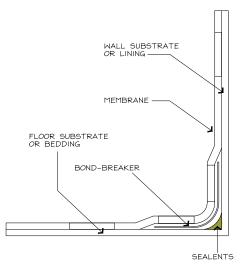

TYPICAL BOND BREAKER CLASS II

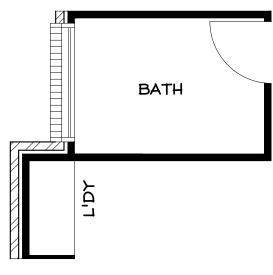

EROSION & SEDIMENT CONTROL PLAN

MAINTAIN AS MANY GRASSED AREAS AS POSSIBLE PARTICUARILY ON THE VERGES TO TRAP SOIL BEFORE IT REACHES THE ROADWAY AND STORMWATER SYSTEM, FENCE OFF UNDISTURBED AREAS

USE ONLY ONE EXIT/ENTRY TO THE SITE. BUILD A STABILISED ACCESS POINT BY USING ROAD BASE, 50mm AGGREGATE, RECYCLED CONCRETE OR SIMILAR

ASSIGN A DESIGNATED PARKING AREA

LIMIT ACCESS TO THE SITE DURING AND IMMEDIATELY AFTER WET WEATHER

KEEP STOCKPILES WITHIN THE SITE AREA AND AWAY FROM THE STORMWATER SYSTEM

INSTALL ON-SITE WASTE COLLECTION


REGULARLY REMOVE ANY SEDIMENT FROM ROADS ADJACENT TO YOUR SITE, DO NOT WASH INTO THE STORMWATER

INSTALL A SEDIMENT CONTROL BARRIER OF GEOTEXTILE FABRIC ON THE LOW SIDE/S OF THE BLOCK (AS NOTED ON THE SITE PLAN AND AS PER DETAIL)

DESIGNATE A BRICK CUTTING AND WASHING AREA AWAY FROM STORMWATER DRAINS.
ENSURE THE AREA IS LARGE ENOUGH TO CONTAIN ALL EXCESS WATER, RESIDUES AND WASTE

REGULARLY CHECK AND MAINTAIN POLLUTION CONTROLS THROUGHOUT CONSTRUCTION

ENSURE THAT THE DEVELOPMENT COMPLIES WITH THE ACT ENVIRONMENT PROTECTION AUTHORITY, ENVIRONMENT PROTECTION GUIDELINES FOR CONSTRUCTION AND LAND DEVELOPMENT IN THE ACT, AUGUST 2007

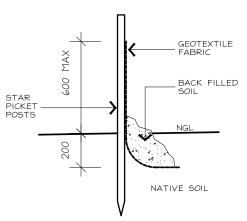

SEDIMENT CONTROL DETAIL

SECTION NOTES:

ALL STRUCTURAL AND NON-STRUCTURAL TIMBER TO BE IN ACCORDANCE WITH THE TIMBER FRAMING CODE ASI684 ALL STRUCTURAL STEEL COLUMNS, POST, BEAMS ALL TO BE CERTIFIED AND DESIGNED BY STRUCTURAL

ENGINEER RC SLAB AND FOOTINGS TO COMPLY WITH ENGINEER'S DETAILS AND AS2870.1

PROVIDE CONTINUOUS DAMP-PROOF MEMBRANE UNDER SLAB TO N.C.C-2022

PROVIDE TERMITE PROTECTION UNDER SLAB TO MAN. SPEC. AND N.C.C-2022

PROVIDE 90x35 MGP OR 90x45 MGP STUDS AS REQUIRED TO ASI684 AND/OR TO MAN. SPECIFICATIONS.

BRACING AS PER N.C.C. AND ENGINEER'S SPECIFICATIONS PLASTERBOARD AND FC LININGS TO INTERNAL WALLS AND CEILINGS AS REQUIRED

PRE-EABRICATED ROOF TRUSSES AS PER MAN SPEC LINTELS AS PER TRUSS MANUFACTURERS CHARTS AND ENGINEER'S SPECIFICATIONS

ALL INSULATION AS PER ATTACHED EER

ALL EXTERNAL SWING DOORS AND INTERNAL ACCESS DOORS TO BE FULLY SEALED

WINDOW SPECIFICATIONS AS PER ATTACHED EER

STANDARD METRIC BRICK 230x110x76mm WITH FLUSH IRONED JOINTS & STRETCHER BOND. BRICKS TIES AND ANCHORAGE TO AS4773. MORTAR MIX: M3 MORTAR MIX OF I-CEMENT, I-LIME, 6-SAND

ALL LOAD BEARING WALLS AND CONTROL JOINTS SPECIFIED TO ENGINEER'S DETAILS FLASHING, WEEP HOLES AND DAMP PROOF COURSE TO COMPLY WITH BCA AND AS4773

ROOF AND EXTERNAL WALL MATERIALS AS NOTED ON ELEVATIONS/SECTION.

ALL EAVES AND GUTTERS TO BE COLORBOND QUAD GUTTERING, INSTALLED TO MANFACTURER'S SPECIFICATIONS.

ALL ROOFING AND BATTEN SPACINGS TO BE INSTALLED TO MAN. SPECIFICATIONS AND N.C.C-2022

PROVIDE PAINTED FC SHEET LININGS TO ALL EAVES EAVES OVERHANG AS DIMENSIONED ON ELEVATIONS AND SECTION DIAGRAM

50mm CAVITY DIMENSION TO EXTERNAL B/V WALL MECHANICAL VENTILATION DUCTED TO EXTERIOR TO COMPLY WITH N.C.C-2022


SHOWER SCREENS AND WET AREA GLAZING TOUGHENED GLASS AS PER N.C.C-2022

FLOW RATE OF MECHANICAL SYSTEMS TO COMPLY WITH BCA V2 3.8.7.3

PROPOSED DEMOLITION OF EXISTING RESIDENCE AND BUILD NEW RESIDENCE:

BLOCK: SECTION: 7 FORREST CLIENT: D SHARMA and

11 Talbot Street Forrest

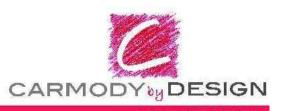

A BURTON of

ABN 58201170896 PO BOX 6121 D'CONNOR ACT 2602 19A FARRER STREET BRADDON GINA@CARMODYBYDESIGN.COM.AU PH: 02 6230 1284

DWN: A.KWONG G.CARMODY SCALE: 1:100 DATE: 8/8/23

DWG No.: 2303 SHEET: 6 OF 7

